

SITE PLAN

SCALE: 1" = 10'-0"



VISION DDB LLC

ED NOTTINGHAM, JR EDNOTTY@VISIONDDB.COM 443.677.0985

APPLICANT
EMMANUEL PRICE
V.P. THRESHOLD INC.
P 443-739-9968

ARDELIA2108.EP@GMAIL.COM

OWNER
THRESHOLD INCORPORATED
1701 ST. PAUL STREET

BALTIMORE, MD 21202

CONTRACTOR

SUBMISSION DATE NOVEMBER 22, 2021						
NO.	REVISION	BY	DATE			
1						
2						
3						
4						
5						
6						
7						

PROFESSIONAL CERTIFICATION
I HEREBY CERTIFY THAT THESE
DOCUMENTS WERE PREPARED OR
APPROVED BY ME, AND THAT I AM
A DULY LICENSED PROFESSIONAL
ARCHITECT UNDER THE LAWS
OF THE STATE OF MARYLAND.

ICENSE NUMBER _____

EXPIRATION DATE

PROJECT INFORMATION

THRESHOLD TOWNHOUSES

400 EAST LAFAYETTE AVE BALTIMORE, MD 21202

> WARD 12 SECTION 11 BLOCK 1096 LOTS 19/20 THRU 11

PROJECT NO THR-2020-09


SHEET TITLE

BUILDING SITE PLAN

DRAWING NUMBER

SHEET NUMBER

2 of 8

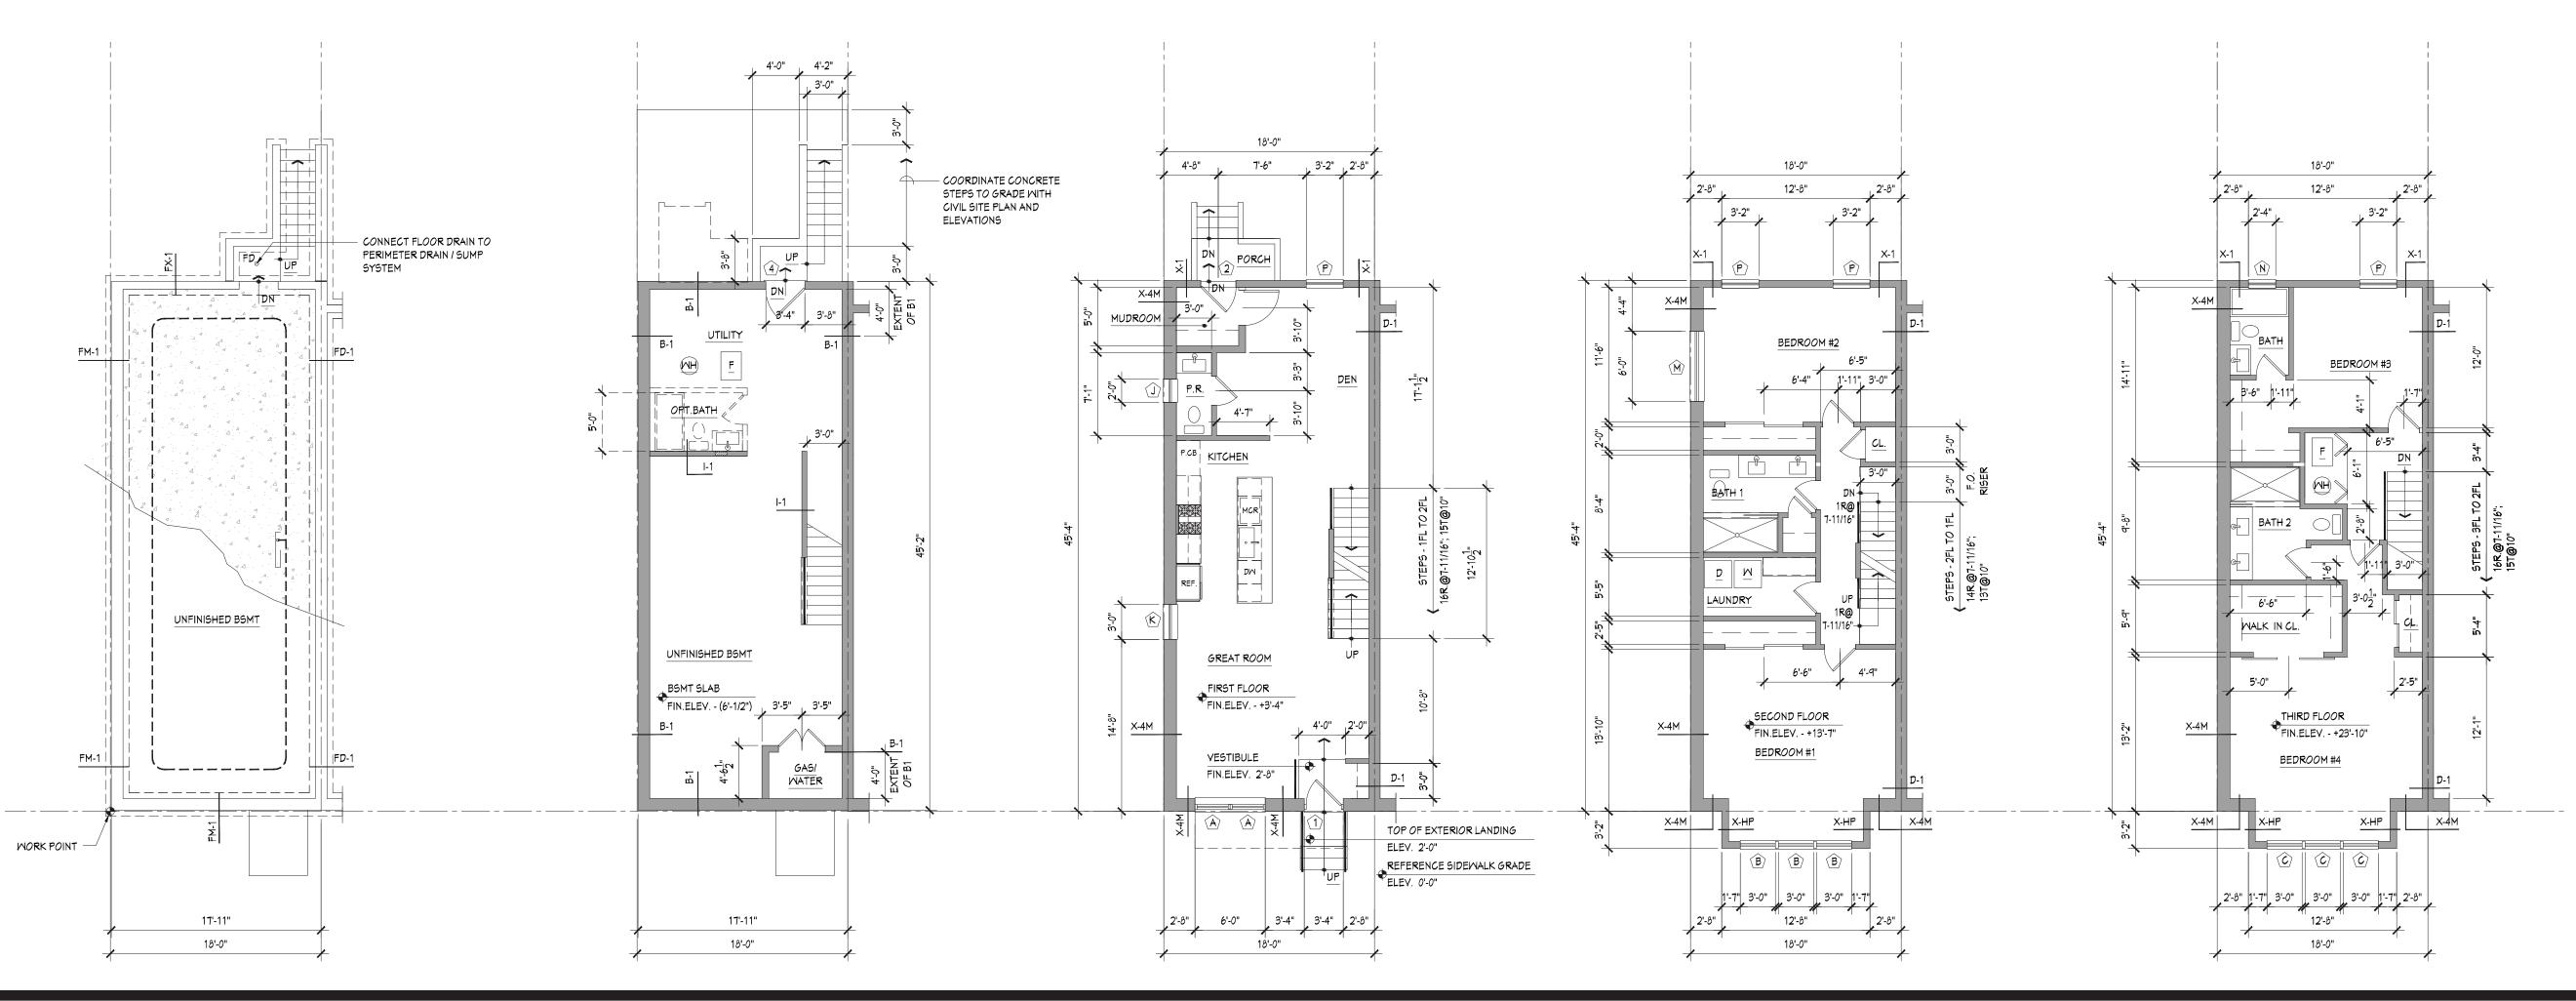

FOUNDATION PLAN


BASEMENT PLAN

FIRST FLOOR PLAN

SECOND FLOOR PLAN

THIRD FLOOR PLAN

SCALE: 1/8" = 1'-0"

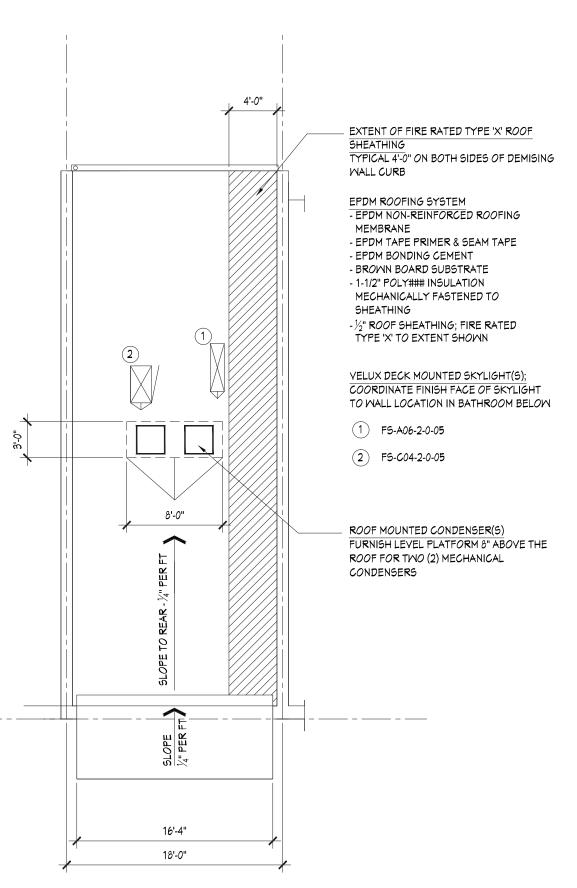

ROOF PLAN

1) ALL EXTERIOR DIMENSIONS ARE TO FINISHED FACE(S) OF WALL ASSEMBLY. 2) ALL INTERIOR DIMENSIONS ARE TO

FACE OF FINISHED DRYWALL

3) ALL GYPSUM WALL BOARD (G.W.B) TO BE LEVEL 4 FINISH, U.O.N.

- DOOR SIZE EX: 3680 (3'-0" × 6'-8") - BF (BI-FOLD) - BN (BARN DOOR) - BSL (BI-PASS SLIDER) - L (LOUYER) - FR (FRENCH DOORS) - PA (IN-SMING PATIO)
- 5) ALL INTERIOR DOORS ARE SOLID CORE DOORS; DESIGN - MASONITE LINCOLN PARK; U.O.N.

7) ALL SPECIFIED OR REFERENCED

6) ALL MINDOM ARE BASED ON ANDERSEN 400 SERIES TILT-WASH

> MATERIALS AND EQUIPMENT TO BE FURNISHED, STORED AND INSTALLED PER MANUFACTURERS DIRECTIVE SO AS TO FULLY SATISFY ALL SAFETY, BUILDING CODE AND WARRANTY GUIDELINES. GENERAL CONTRACTOR AND ASSOCIATED SUBCONTRACTOR ARE SPECIFICALLY RESPONSIBLE TO BRING ANY DESIGN CONDITION DEEMED IRREGULAR TO THE WRITTEN ATTENTION OF THE ARCHITECT PRIOR TO INSTALLTION FOR CORRECTIVE MEASURES AS NEEDED.

- 8) BRICK VENEER SPEC: BELDEN SIMULATED BELCREST 530 SIZE: STANDARD MODULAR 3 ½" × 2 ¼" × 7 ½"
- ALT. FOR PRICING BELDEN GRAY: 691-693 SMOOTH SIZE: STANDARD MODULAR 3 ½" × 2 ½" × 7 ½"

9) FOR ANDERSEN E-SERIES (TCLDH) DOUBLE HUNG WINDOWS, FRAMER TO VERIFY MINIMUM ROUGH OPENINGS & OFFSETS PER MANUFACTURERS DIRECTIVE PRIOR TO FRAMING START.

10) AS NEEDED, PROVIDE TEMPERED GLASS FOR WINDOWS WITH SILLS <18" ABOVE FINISH FLOOR ELEVATION

TYPICAL EXTERIOR WALL (X-1) 1/2" G.M.B.; TAPE & FINISH (T&F) - 2"X 6" MOOD STUDS @ 16" O.C. - R-21 BATT INSULATION (IEC ZONE 4) 1/2" DENS GLASS GOLD EXTERIOR - TYVEX COMMERCIAL BUILDING WRAP (EXTERIOR FINISH PER ELEVATIONS AND

AS NOTED BELOW;) 4) DOOR ABBREVIATIONS ARE: FOR ADDED MASONRY VENEERS; - 4" BRICK VENEER (X-4M)

- 4" LIMESTONE PANELS (X-4L) FOR HARDI-PANEL VENEER (X-HP)

> TYPICAL INTERIOR WALL (I-1) 1/2" G.W.B. BOTH SIDES; T&F (LEVEL 4) - 2" × 4" MOOD STUDS @ 16" OC - PROVIDE P.T. WOOD PLATE WHEN INSTALLED ON CONCRETE FLOOR

FOR WET / TILE LOCATIONS, SUBSTITUTE 1/3" G.W.B. WITH; $-\frac{1}{2}$ " M.R. G.W.B. FOR PAINT (I-1MR) $-\frac{1}{2}$ " DUROCK AT TILE FINISH (I-1D)

DEMISING WALL ASSEMBLY (D-1) DESIGN - U.L. U347; SPECIFIED STC - 55

INSTALL AS SPECIFIED PER U.L. GUIDELINES. PROVIDE COPY OF UL ASSEMBLY SPEC FOR APPROVAL BY ARCHITECT PRIOR TO INSTALLATION.

- TWO (2) LAYERS OF 1" FIRE-SHIELD SHAFTLINER INSERTED IN 2" H-STUD - 3/4" AIR SPACE (BOTH SIDES) - 2" X 4" WOOD STUDS @ 16" O.C.; - 5/8" TYPE 'X' G.W.B.; TYP. BOTH SIDES

FURRED INTERIOR WALL (F-1) - 1-1/2" R-7.5 FOAMULAR 150 RIGID FOAM INSULATION BOARD MECHANICALLY FASTENED TO CONCRETE WALL; TAPE ALL SEAMS WITH XXX - 1" AIR SPACE - 2" X 4" WOOD STUDS @ 16" O.C.; PROVIDE P.T. WOOD PLATE AT CONCRETE FLOOR; PROVIDE FIRE BLOCKING AT TOP OF

 $-\frac{1}{2}$ " M.R. GYP. WALL BOARD

INSULATED BASEMENT WALL (B-1) - 1-1/2" R-7.5 FOAMULAR 150 RIGID FOAM INSULATION BOARD MECHANICALLY FASTENED TO CONCRETE WALL; TAPE ALL SEAMS WITH XXX

FOUNDATION WALLS FM-1 - 12" REINFORCED CONCRETE PER STRUCTURAL WITH 4" BRICK LEDGE FOR MASONRY WALLS; BRICK LEDGE

ELEV.MIN. 8' BELOW FINISHED FD-1 - 12" REINFORCED CONCRETE FOUNDATION WALL PER

STRUCTURAL FOR DEMISING WALLS. FX-1 - 8" REINFORCED CONRETE

> FOUNDATION WALL PER STRUCUTRAL FOR NON-MASONRY EXTERIOR WALLS

VISION DDB LLC ED NOTTINGHAM, JR EDNOTTY@VISIONDDB.COM 443.677.0985

APPLICANT EMMANUEL PRICE V.P. THRESHOLD INC. P 443-739-9968 ARDELIA2108.EP@GMAIL.COM

THRESHOLD INCORPORATED 1701 ST. PAUL STREET BALTIMORE, MD 21202

CONTRACTOR

	NOVEMBE	ER 22, 2	2021
NO.	REVISION	ву	DAT
1			
2			
3			
4			
5			
6			
7			
8			

A DULY LICENSED PROFESSIONAL ARCHITECT UNDER THE LAWS OF THE STATE OF MARYLAND. EXPIRATION DATE _

PROJECT INFORMATION

UNIT A THRESHOLD TOWNHOUSE

400 EAST LAFAYETTE AVE BALTIMORE, MD 21202

> SECTION 11 **BLOCK 1096** LOT 19/20


PROJECT NO THR-2020-09

SHEET TITLE


PLANS NOTES

> **DRAWING NUMBER A-3**

SHEET NUMBER 3 OF 8

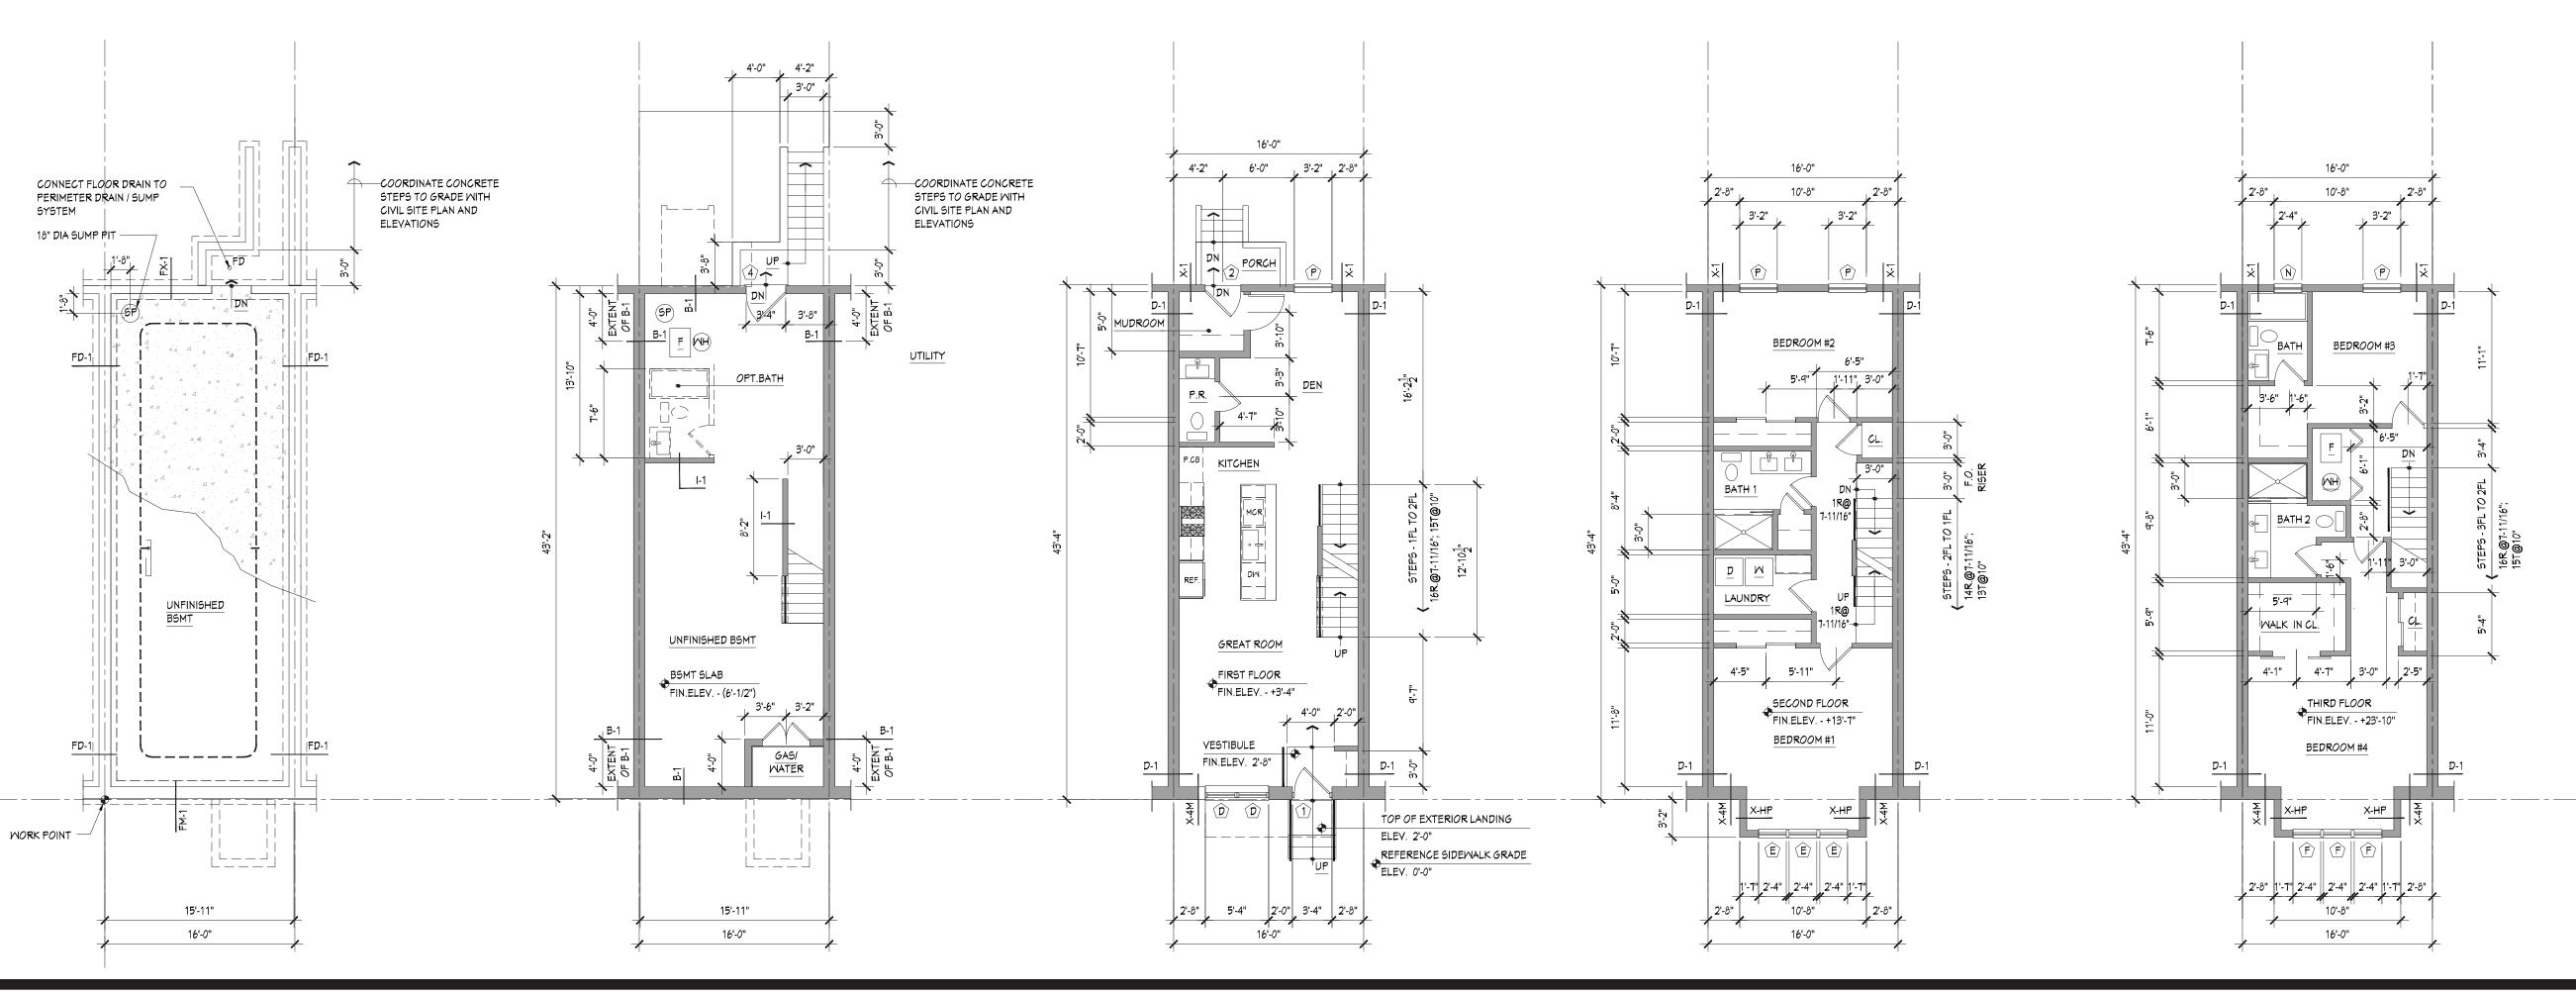

FOUNDATION PLAN **SCALE: 1/8" = 1'-0"** BASEMENT PLAN FIRST FLOOR PLAN SECOND FLOOR PLAN THIRD FLOOR PLAN

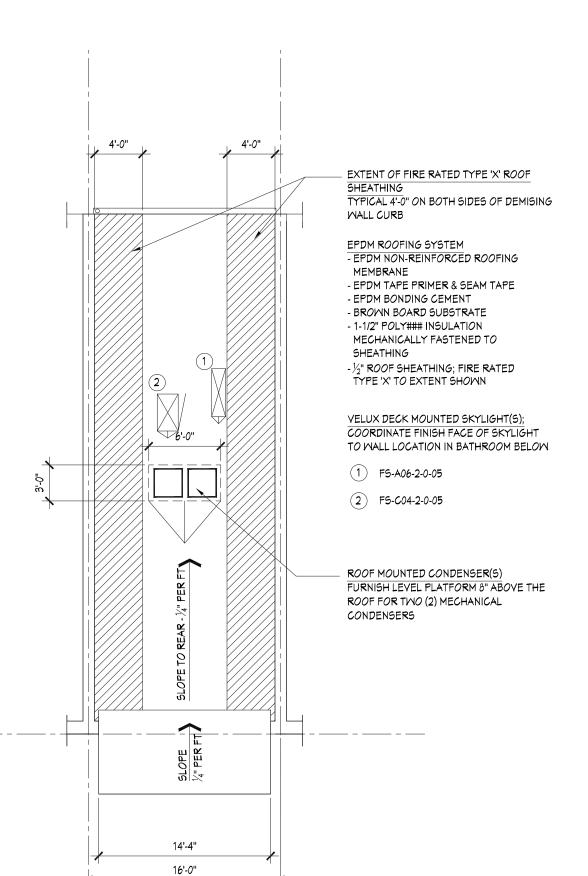

ROOF PLAN

GENERAL NOTES

FINISHED FACE(S) OF WALL ASSEMBLY.

2) ALL INTERIOR DIMENSIONS ARE TO FACE OF FINISHED DRYWALL

4) DOOR ABBREVIATIONS ARE:

- BF (BI-FOLD) - BN (BARN DOOR) - BSL (BI-PASS SLIDER) - L (LOUYER)

- FR (FRENCH DOORS)

- PA (IN-SWING PATIO) 5) ALL INTERIOR DOORS ARE SOLID CORE DOORS; DESIGN - MASONITE

LINCOLN PARK; U.O.N.

6) ALL WINDOW ARE BASED ON ANDERSEN 400 SERIES TILT-WASH

7) ALL SPECIFIED OR REFERENCED MATERIALS AND EQUIPMENT TO BE FURNISHED, STORED AND INSTALLED PER MANUFACTURERS DIRECTIVE SO AS TO FULLY SATISFY ALL SAFETY, BUILDING CODE AND WARRANTY GUIDELINES. GENERAL CONTRACTOR INSTALL AS SPECIFIED PER U.L. AND ASSOCIATED SUBCONTRACTOR ARE SPECIFICALLY RESPONSIBLE TO BRING ANY DESIGN CONDITION DEEMED IRREGULAR TO THE WRITTEN ATTENTION OF THE ARCHITECT PRIOR - TWO (2) LAYERS OF 1" FIRE-SHIELD TO INSTALLTION FOR CORRECTIVE MEASURES AS NEEDED.

8) BRICK VENEER SPEC: BELDEN SIMULATED BELCREST 530 - 5/8" TYPE 'X' G.W.B.; TYP. BOTH SIDES SIZE: STANDARD MODULAR 3 ½" × 2 ¼" × 7 ½"

ALT. FOR PRICING BELDEN GRAY: 691-693 SMOOTH SIZE: STANDARD MODULAR 3 ½" × 2 ¼" × 7 ½"

9) FOR ANDERSEN E-SERIES (TCLDH) DOUBLE HUNG WINDOWS, FRAMER TO VERIFY MINIMUM ROUGH OPENINGS & OFFSETS PER MANUFACTURERS DIRECTIVE PRIOR TO FRAMING START.

10) AS NEEDED, PROVIDE TEMPERED GLASS FOR WINDOWS WITH SILLS <18" ABOVE FINISH FLOOR ELEVATION

WALL TYPES & NOTES

1) ALL EXTERIOR DIMENSIONS ARE TO TYPICAL EXTERIOR WALL (X-1) - ½" G.M.B.; TAPE & FINISH (T&F) - 2"X 6" WOOD STUDS @ 16" O.C. - R-21 BATT INSULATION (IEC ZONE 4) $-\frac{1}{2}$ " DENS GLASS GOLD EXTERIOR

3) ALL GYPSUM WALL BOARD (G.W.B) - TYVEX COMMERCIAL BUILDING WRAP TO BE LEVEL 4 FINISH, U.O.N. (EXTERIOR FINISH PER ELEVATIONS AND AS NOTED BELOW;)

- DOOR SIZE - EX: 3680 (3'-0" X 6'-8") FOR ADDED MASONRY VENEERS; - 4" BRICK VENEER (X-4M) - 4" LIMESTONE PANELS (X-4L)

FOR HARDI-PANEL VENEER (X-HP)

TYPICAL INTERIOR MALL (I-1) -1/2" G.W.B. BOTH SIDES; T&F (LEVEL 4) - 2" × 4" MOOD STUDS @ 16" OC - PROVIDE P.T. WOOD PLATE WHEN INSTALLED ON CONCRETE FLOOR

FOR WET / TILE LOCATIONS, SUBSTITUTE $\frac{1}{2}$ " G.W.B. WITH; $-\frac{1}{2}$ " M.R. G.W.B. FOR PAINT (I-1MR) $-\frac{1}{2}$ " DUROCK AT TILE FINISH (I-1D)

DEMISING WALL ASSEMBLY (D-1) DESIGN - U.L. U347; SPECIFIED STC - 55

GUIDELINES. PROVIDE COPY OF UL ASSEMBLY SPEC FOR APPROVAL BY ARCHITECT PRIOR TO INSTALLATION. SHAFTLINER INSERTED IN 2" H-STUD $-\frac{3}{4}$ " AIR SPACE (BOTH SIDES)

- 2" X 4" MOOD STUDS @ 16" O.C.;

TYP. BOTH SIDES

FURRED INTERIOR WALL (F-1)

- 1-1/2" R-7.5 FOAMULAR 150 RIGID FOAM INSULATION BOARD MECHANICALLY FASTENED TO CONCRETE WALL; TAPE ALL SEAMS WITH XXX - 1" AIR SPACE

- 2" X 4" WOOD STUDS @ 16" O.C.; PROVIDE P.T. WOOD PLATE AT CONCRETE FLOOR; PROVIDE FIRE BLOCKING AT TOP OF

 $-\frac{1}{2}$ " M.R. GYP. WALL BOARD

INSULATED BASEMENT MALL (B-1) - 1-1/2" R-7.5 FOAMULAR 150 RIGID FOAM INSULATION BOARD MECHANICALLY FASTENED TO CONCRETE WALL;

TAPE ALL SEAMS WITH XXX

FOUNDATION WALLS FM-1 - 12" REINFORCED CONCRETE PER STRUCTURAL WITH 4" BRICK LEDGE FOR MASONRY WALLS; BRICK LEDGE ELEV.MIN. 8' BELOW FINISHED

FD-1 - 12" REINFORGED CONCRETE FOUNDATION WALL PER

STRUCTURAL FOR DEMISING WALLS. FX-1 - 8" REINFORCED CONRETE

FOUNDATION WALL PER STRUCUTRAL

FOR NON-MASONRY EXTERIOR WALLS

VISION DDB LLC

ED NOTTINGHAM, JR EDNOTTY@VISIONDDB.COM 443.677.0985

APPLICANT EMMANUEL PRICE V.P. THRESHOLD INC. P 443-739-9968 ARDELIA2108.EP@GMAIL.COM

OWNER THRESHOLD INCORPORATED 1701 ST. PAUL STREET BALTIMORE, MD 21202

CONTRACTOR

SUBMISSION DATE NOVEMBER 22, 2021

DULY LICENSED PROFESSIONAL ARCHITECT UNDER THE LAWS OF THE STATE OF MARYLAND.

EXPIRATION DATE _

PROJECT INFORMATION

UNIT B THRESHOLD TOWNHOUSES

400 EAST LAFAYETTE AVE BALTIMORE, MD 21202

> WARD 12 SECTION 11 **BLOCK 1096** LOTS 12-18A


PROJECT NO THR-2020-09

SHEET TITLE

PLANS NOTES

> **DRAWING NUMBER A-4**

SHEET NUMBER 4 of 8

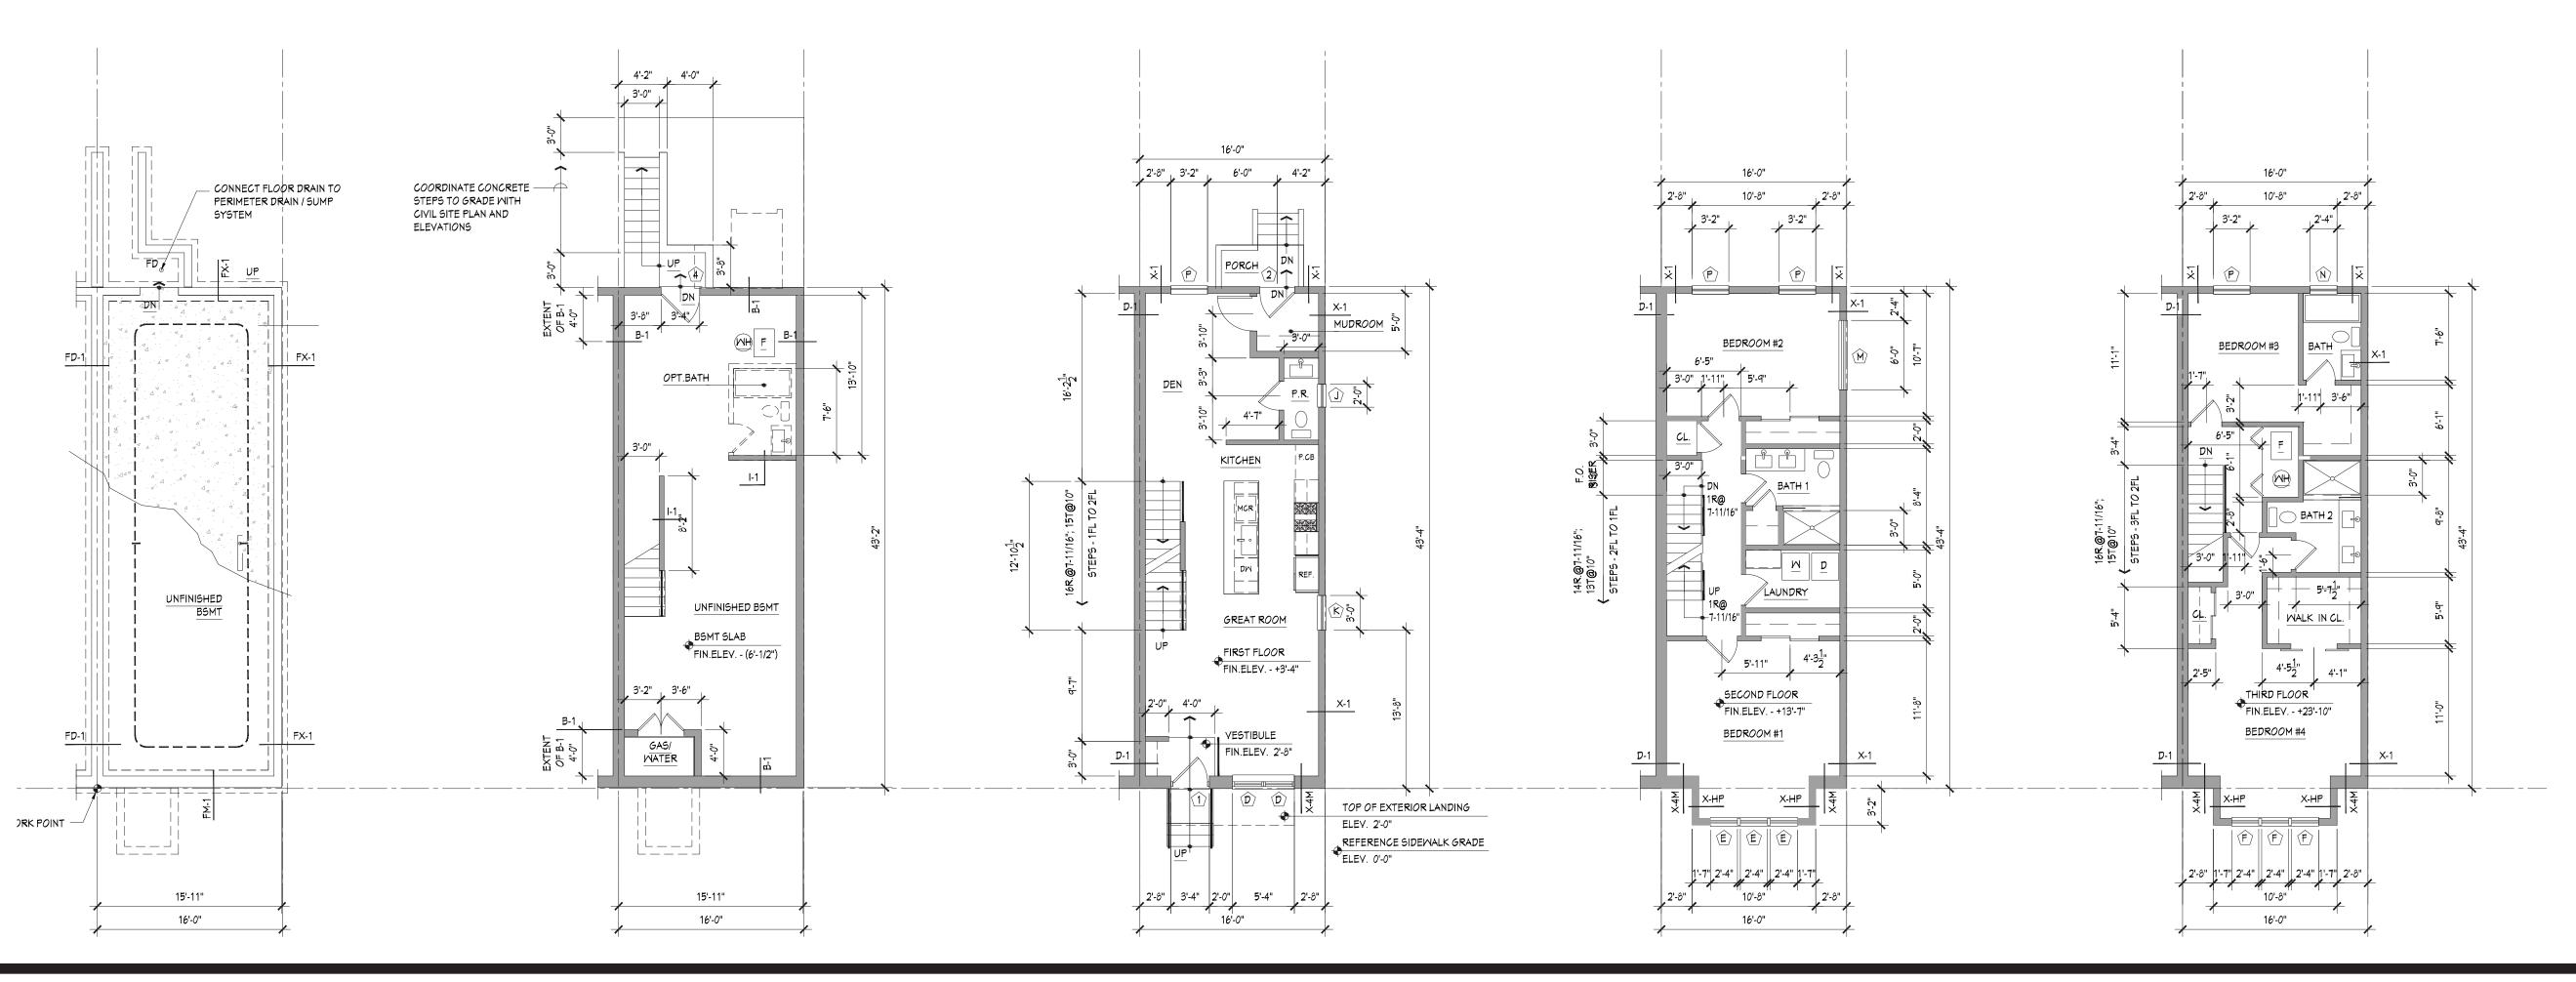


FOUNDATION PLAN BASEMENT PLAN FIRST FLOOR PLAN

SECOND FLOOR PLAN

THIRD FLOOR PLAN

SCALE: 1/8" = 1'-0"

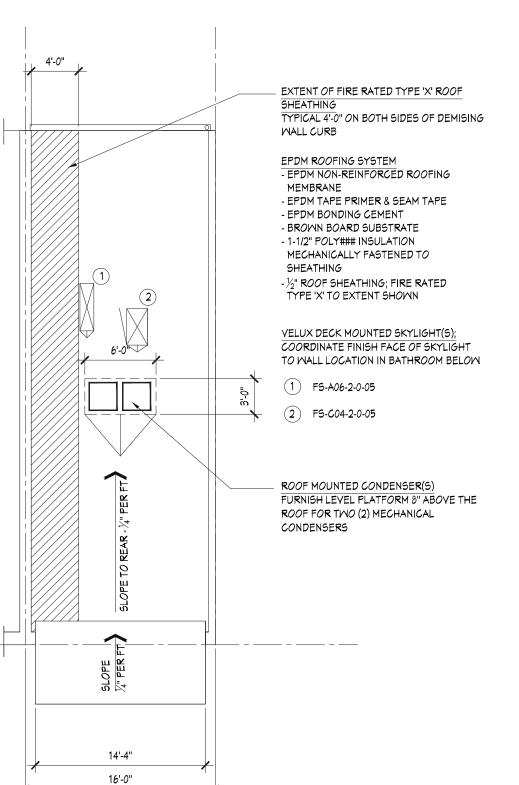

GENERAL NOTES

1) ALL EXTERIOR DIMENSIONS ARE TO TYPICAL EXTERIOR WALL (X-1) FINISHED FACE(S) OF WALL ASSEMBLY. 2) ALL INTERIOR DIMENSIONS ARE TO

3) ALL GYPSUM WALL BOARD (G.W.B) TO BE LEVEL 4 FINISH, U.O.N.

4) DOOR ABBREVIATIONS ARE:

- BN (BARN DOOR) - BSL (BI-PASS SLIDER) - L (LOUYER) - FR (FRENCH DOORS)

- PA (IN-SWING PATIO) 5) ALL INTERIOR DOORS ARE SOLID CORE DOORS; DESIGN - MASONITE LINCOLN PARK; U.O.N.

6) ALL WINDOW ARE BASED ON ANDERSEN 400 SERIES TILT-WASH

7) ALL SPECIFIED OR REFERENCED MATERIALS AND EQUIPMENT TO BE FURNISHED, STORED AND INSTALLED PER MANUFACTURERS DIRECTIVE SO AS TO FULLY SATISFY ALL SAFETY, BUILDING CODE AND WARRANTY GUIDELINES. GENERAL CONTRACTOR INSTALL AS SPECIFIED PER U.L. AND ASSOCIATED SUBCONTRACTOR ARE SPECIFICALLY RESPONSIBLE TO BRING ANY DESIGN CONDITION DEEMED IRREGULAR TO THE WRITTEN ATTENTION OF THE ARCHITECT PRIOR - TWO (2) LAYERS OF 1" FIRE-SHIELD TO INSTALLTION FOR CORRECTIVE MEASURES AS NEEDED.

8) BRICK VENEER SPEC: SIZE: STANDARD MODULAR 3 ½" × 2 ¼" × 7 ½"

> ALT. FOR PRICING BELDEN GRAY: 691-693 SMOOTH SIZE: STANDARD MODULAR 3 ½" × 2 ¼" × 7 ½"

9) FOR ANDERSEN E-SERIES (TCLDH) DOUBLE HUNG WINDOWS, FRAMER TO VERIFY MINIMUM ROUGH OPENINGS & OFFSETS PER MANUFACTURERS DIRECTIVE PRIOR TO FRAMING START.

10) AS NEEDED, PROVIDE TEMPERED GLASS FOR WINDOWS WITH SILLS <18" ABOVE FINISH FLOOR ELEVATION

WALL TYPES & NOTES

- ½" G.M.B.; TAPE & FINISH (T&F) - 2"X 6" WOOD STUDS @ 16" O.C. - R-21 BATT INSULATION (IEC ZONE 4) FACE OF FINISHED DRYWALL $-\frac{1}{2}$ " DENS GLASS GOLD EXTERIOR - TYVEX COMMERCIAL BUILDING WRAP

AS NOTED BELOW;) - DOOR SIZE - EX: 3680 (3'-0" X 6'-8") FOR ADDED MASONRY VENEERS; - BF (BI-F*O*LD) - 4" BRICK VENEER (X-4M)

- 4" LIMESTONE PANELS (X-4L) FOR HARDI-PANEL VENEER (X-HP)

(EXTERIOR FINISH PER ELEVATIONS AND

TYPICAL INTERIOR MALL (I-1) -1/2" G.W.B. BOTH SIDES; T&F (LEVEL 4) - 2" × 4" MOOD STUDS @ 16" OC - PROVIDE P.T. WOOD PLATE WHEN INSTALLED ON CONCRETE FLOOR

FOR WET / TILE LOCATIONS, SUBSTITUTE $\frac{1}{2}$ " G.W.B. WITH; $-\frac{1}{2}$ " M.R. G.W.B. FOR PAINT (I-1MR) $-\frac{1}{2}$ " DUROCK AT TILE FINISH (I-1D)

DEMISING WALL ASSEMBLY (D-1) DESIGN - U.L. U347; SPECIFIED STC - 55

GUIDELINES. PROVIDE COPY OF UL ASSEMBLY SPEC FOR APPROVAL BY ARCHITECT PRIOR TO INSTALLATION.

SHAFTLINER INSERTED IN 2" H-STUD $-\frac{3}{4}$ " AIR SPACE (BOTH SIDES) - 2" X 4" MOOD STUDS @ 16" O.C.; TYP. BOTH SIDES BELDEN SIMULATED BELCREST 530 - 5/8" TYPE 'X' G.W.B.; TYP. BOTH SIDES

FURRED INTERIOR WALL (F-1) - 1-1/2" R-7.5 FOAMULAR 150 RIGID FOAM INSULATION BOARD MECHANICALLY FASTENED TO CONCRETE WALL; TAPE ALL SEAMS WITH XXX - 1" AIR SPACE - 2" X 4" WOOD STUDS @ 16" O.C.; PROVIDE P.T. WOOD PLATE AT CONCRETE FLOOR; PROVIDE FIRE BLOCKING AT TOP OF

 $-\frac{1}{2}$ " M.R. GYP. WALL BOARD

INSULATED BASEMENT MALL (B-1) - 1-1/2" R-7.5 FOAMULAR 150 RIGID FOAM INSULATION BOARD MECHANICALLY FASTENED TO CONCRETE WALL; TAPE ALL SEAMS WITH XXX

FOUNDATION WALLS FM-1 - 12" REINFORCED CONCRETE PER STRUCTURAL WITH 4" BRICK LEDGE FOR MASONRY WALLS; BRICK LEDGE ELEV.MIN. 8' BELOW FINISHED

FD-1 - 12" REINFORCED CONCRETE FOUNDATION WALL PER STRUCTURAL FOR DEMISING WALLS.

FX-1 - 8" REINFORCED CONRETE FOUNDATION WALL PER STRUCUTRAL FOR NON-MASONRY EXTERIOR WALLS

VISION 5B LLC
DEVELOPMENT DESIGN BUILD

ED NOTTINGHAM, JR EDNOTTY@VISIONDDB.COM 443.677.0985

APPLICANT EMMANUEL PRICE V.P. THRESHOLD INC. P 443-739-9968 ARDELIA2108.EP@GMAIL.COM

OWNER THRESHOLD INCORPORATED 1701 ST. PAUL STREET

BALTIMORE, MD 21202

CONTRACTOR

	SUBMISS NOVEMBE		
NO.	REVISION	ВУ	DATE
1			
2			
3			
4			
5	·		

DULY LICENSED PROFESSIONAL ARCHITECT UNDER THE LAWS

OF THE STATE OF MARYLAND.

EXPIRATION DATE _

PROJECT INFORMATION

UNIT C THRESHOLD

TOWNHOUSE

400 EAST LAFAYETTE AVE BALTIMORE, MD 21202

> WARD 12 SECTION 11 **BLOCK 1096** LOT 11


PROJECT NO THR-2020-09

SHEET TITLE


PLANS NOTES

> **DRAWING NUMBER A-5**

SHEET NUMBER 5 OF 8

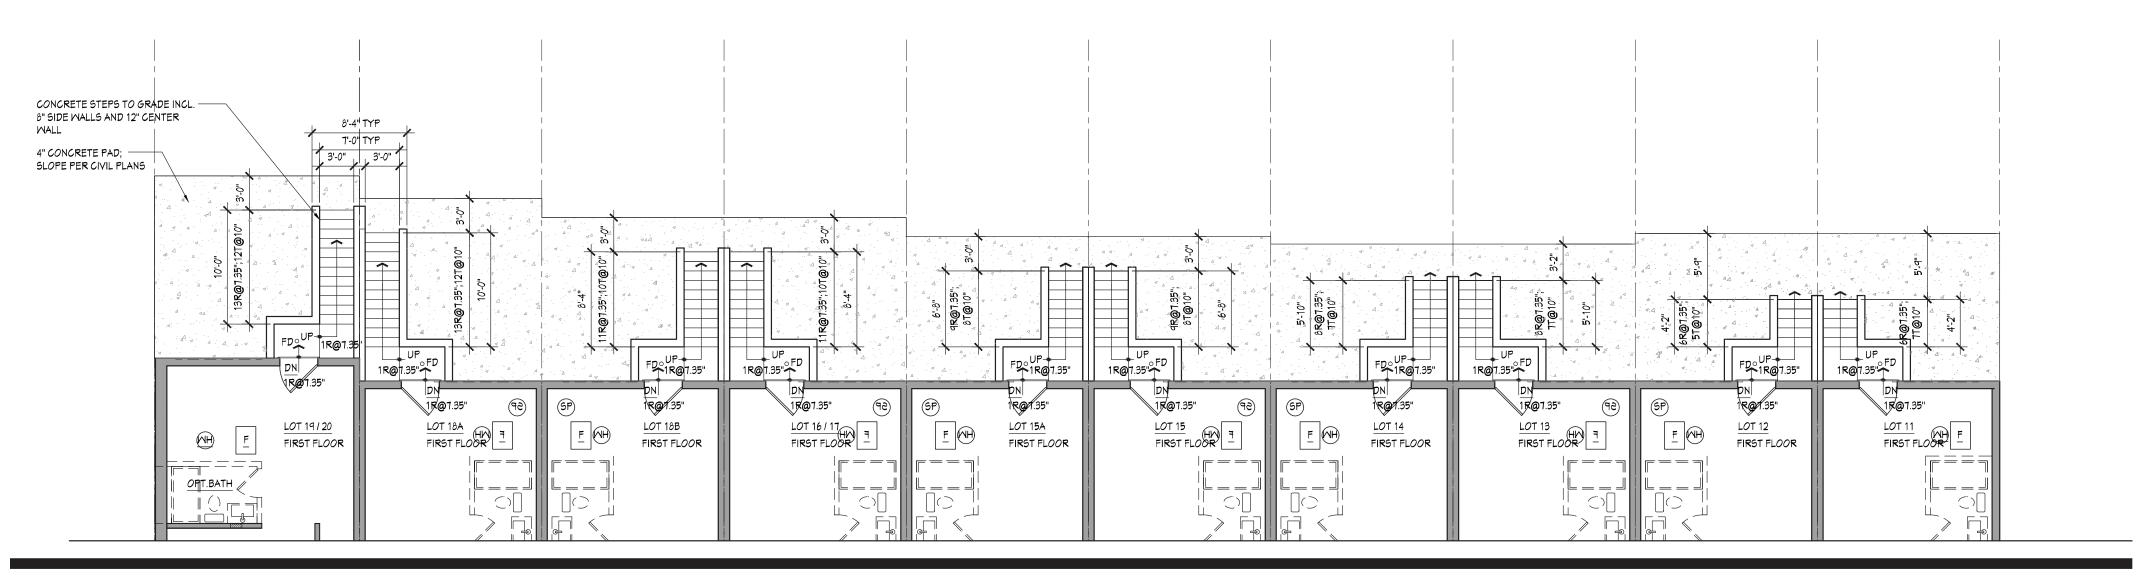

REAR EGRESS DETAIL - BASEMENT TO GRADE

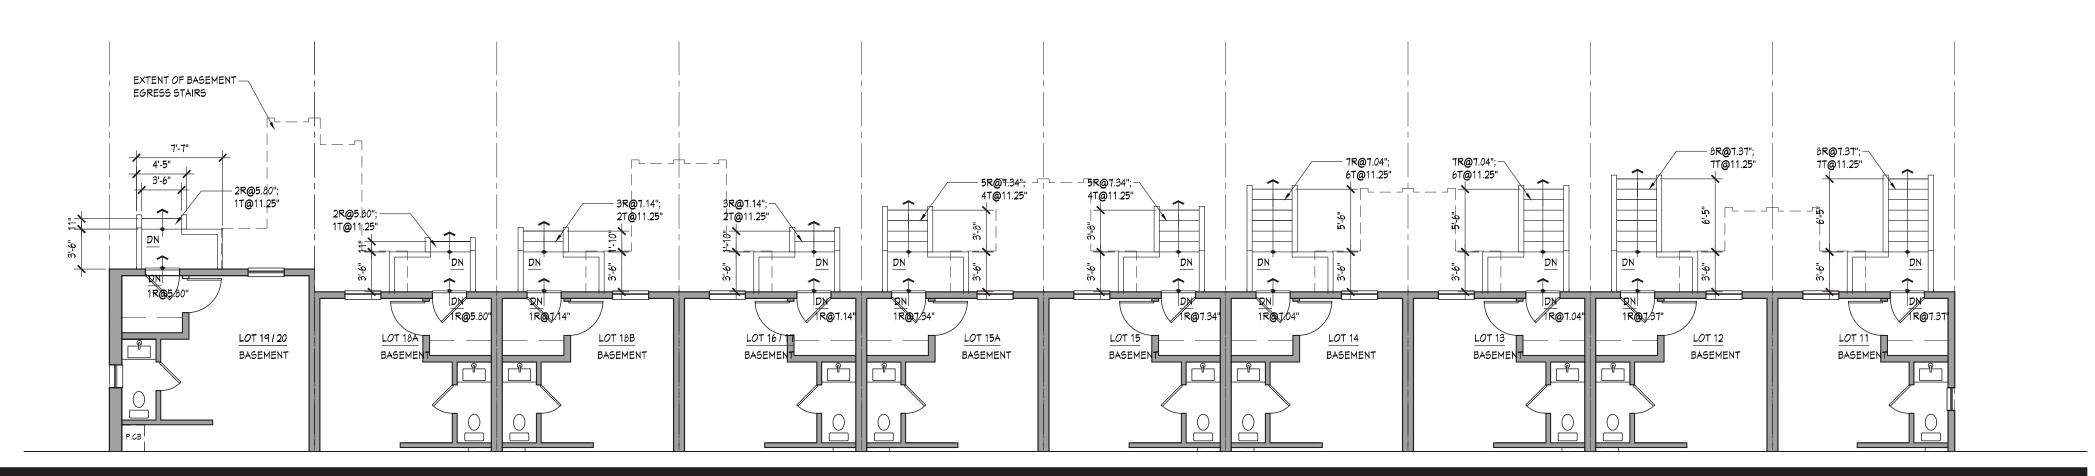

REAR EGRESS DETAIL - 1ST FLOOR TO GRADE

THRESHOLD REAR YARD ACCESS ELEVATIONS

RISER HGT MAX					7.75			
				FIR	ST FLOOR TO REAR G	RADE		
LOT NUMBER	ADDRESS	1FL ELEV	REAR GRADE	ELEV CHANGE TO GRADE (IN.)	# OF STEPS TO GRADE	TYPICAL RISER HGT	REAR LANDING (1 STEP)	STEPS TO GRADE
19/20	400	106.33	104.88	17.4	3.00	5.80	5.80	2.00
18A	402	106.33	104.88	17.4	3.00	5.80	5.80	2.00
18B	404	105.33	102.95	28.56	4.00	7.14	7.14	3.00
16/17	406	105.33	102.95	28.56	4.00	7.14	7.14	3.00
15A	408	104.68	101.01	44.04	6.00	7.34	7.34	5.00
15	410	104.68	101.01	44.04	6.00	7.34	7.34	5.00
14	412	103.73	99.04	56.28	8.00	7.04	7.04	7.00
13	414	103.73	99.04	56.28	8.00	7.04	7.04	7.00
12	416	102.58	97.05	66.36	9.00	7.37	7.37	8.00
11	418	102.58	97.05	66.36	9.00	7.37	7.37	8.00

				RISER HGT MAX	7.75				
					BASEMENT T	O REAR GRADE			
LOT NUMBER	ADDRESS	BASEMENT ELEV	BSMT LANDING ELEV (-7.75")	REAR GRADE	ELEV CHANGE TO GRADE (IN.)	# OF STEPS TO GRADE	TYPICAL RISER HGT	BSMT LANDING (1 STEP)	STEPS TO GRADE
19/20	400	96.96	96.31	104.88	102.85	14.00	7.35	7.35	13.00
18A	402	96.96	96.31	104.88	102.85	14.00	7.35	7.35	13.00
18B	404	95.96	95.31	102.95	91.69	12.00	7.64	7.64	11.00
16/17	406	95.96	95.31	102.95	91.69	12.00	7.64	7.64	11.00
15A	408	95.31	94.66	101.01	76.21	10.00	7.62	7.62	9.00
15	410	95.31	94.66	101.01	76.21	10.00	7.62	7.62	9.00
14	412	94.36	93.71	99.04	63.97	9.00	7.11	7.11	8.00
13	414	94.36	93.71	99.04	63.97	9.00	7.11	7.11	8.00
12	416	93.21	92.56	97.05	53.89	7.00	7.70	7.70	6.00
11	418	93.21	92.56	97.05	53.89	7.00	7.70	7.70	6.00

EGRESS STAIR CALCULATIONS



VISION DDB LLC DEVELOPMENT DESIGN BUILD

ED NOTTINGHAM, JR EDNOTTY@VISIONDDB.COM 443.677.0985

APPLICANT

EMMANUEL PRICE

V.P. THRESHOLD INC.

P 443-739-9968

ARDELIA 2108. EP@GMAIL. COM

OWNER
THRESHOLD INCORPORATED
1701 ST. PAUL STREET
BALTIMORE, MD 21202

CONTRACTOR

SUBMISSION DATE	
NOVEMBER 22, 2021	

NO.	REVISION	BY	DATE
1			
2			
3			
4			
5			
6			
7			
8			

PROFESSIONAL CERTIFICATION
I HEREBY CERTIFY THAT THESE
DOCUMENTS WERE PREPARED OR
APPROVED BY ME, AND THAT I AM
A DULY LICENSED PROFESSIONAL
ARCHITECT UNDER THE LAWS
OF THE STATE OF MARYLAND.

LICENSE NUMBER ____

EXPIRATION DATE ___

PROJECT INFORMATION

THRESHOLD

400 EAST LAFAYETTE AVE BALTIMORE, MD 21202

TOWNHOUSES

WARD 12 SECTION 11 BLOCK 1096 LOTS 19/20 THRU 11

PROJECT NO THR-2020-09

SHEET TITLE

BUILDING REAR EGRESS

DRAWING NUMBER

6 OF 8



FRONT BUILDING ELEVATION - LAFAYETTE STREET ELEVATION

THIRD FLOOR ELEV. 23.83' SECOND FLOOR ELEV. 13.58' ELEV. (6.04')

REAR BUILDING ELEVATION - BOWEN ALLEY ELEVATION

SCALE: 1/8" = 1'-0"


SCALE: 1/8" = 1'-0"


- (A) CORNICE WITH FIVE (5) CUSTOM MILLED RIGID PVC BRACKETS AND TRIM PER
- HARDI-PANEL BOARD & BATTEN SIDING; FINISH: SMOOTH COLOR: TBD FROM "THE STATEMENT COLLECTION"
- BRICK VENEER DESIGN SPEC MANUF: BELDEN STYLE: SIMULATED BELCREST 530 SIZE: STANDARD MODULAR 3 ½" × 2 ½" × 7 ½"
-) BRICK VENEER DESIGN SPEC (ALTERNATE) MANUF: BELDEN STYLE: GRAY; 691-693 SMOOTH SIZE: STANDARD MODULAR 3 ⅓"×2¼"×7 ⅓"
- (E) 8" PRECAST CONCRETE LINTEL AT BRICK FACADES ONLY; EXTEND 4" BOTH SIDES OF OPENING.
- F NOT USED


- 4" PRECAST CONCRETE SILL AT BRICK FACADES ONLY; MATCH WINDOW WIDTH INCLUDING BRICK MOLDING
- H) 4" THICK LIMESTONE WAINSCOT PANELS; FRONT FACADE ONLY
- BRICK STEPS; MATCH VENEER
- $^{(K)}$ 1-1/2" WROUGHT IRON HANDRAILS WITH $^{1}\!\!\!/_{2}$ " PICKETS AT 4" O.C.; HANDRAIL HEIGHT 38" ABOVE STAIR TREADS; TYPICAL BOTH
- 2" BRONZE ALUMINUM WALL CAP WITH DRIP EDGE OVER PRESSURE TREATED (P.T.) 2" WOOD PLATE ; TYPICAL ON BRICK VENEER WALLS AND DEMISING WALLS
- M 6" HARDI-BOARD TRIM
- N) 6" K-STYLE ALUMINUM GUTTER WITH 4" DIA. DOWNSPOUT; TYPICAL ONE SIDE
- (P) 4" HARDI-BOARD TRIM DOOR AND WINDOW SURROUNDS (1) P.T. WOOD DECK INCLUDING RAILING AND

PICKETS PER DETAIL X-XX; APPLY TWO (2) COATS CLEAR MATTE WATERSEAL.

- (R) 1" ALUMINUM RAILING WITH 1/2" PICKETS @ 4" O.C.; PROVIDE BASED PLATE TO BOLT RAILING TO TOP OF CONCRETE FOUNDATION WALL. PROVIDE SINGLE LINE RAILING FOR BASEMENT STEPS. PROVIDE
- BRACKET TO ALLOW INSTALLATION ON CONCRETE WALL; TYPICAL ONE SIDE BRICK STAMP CONCRETE FOUNDATION
- MALL; NOT PAINTED CONCRETE STEPS TO GRADE FROM MALKOUT BASEMENT
- OPTIONAL

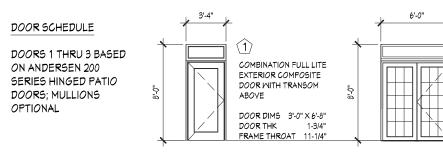


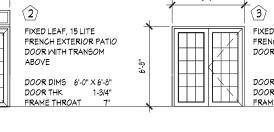


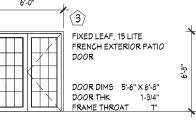





EXTERIOR FLUSH STEEL

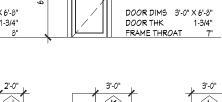


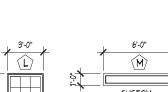


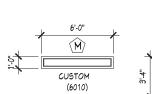


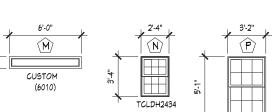




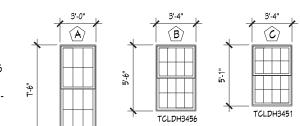

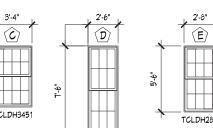


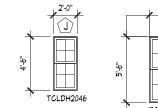


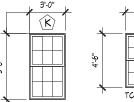



EXTERIOR PRE-HUNG


INSULATED FIBERGLASS DOOR; STYLE T.B.D. WFULL

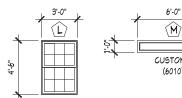

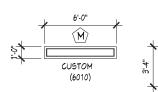

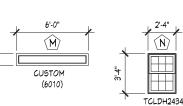

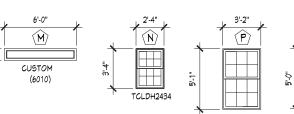

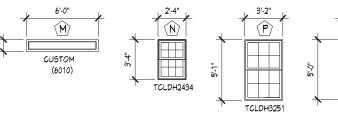



VISION DDB LLC

ED NOTTINGHAM, JR EDNOTTY@VISIONDDB.COM 443.677.0985

APPLICANT JOHN COLLICK 711 MATTHEWS AVENUE BALTIMORE, MD 21225

JOHN & ERIN COLLICK

711 MATTHEWS AVENUE BALTIMORE, MD 21225

CONTRACTOR 711 MATTHEWS AVENUE

BALTIMORE, MD 21225

	REVISION	BY	
1			
2			
3			
4			
5			
6			
7			
8			

OF	THE	STATE	OF	MARYLAND	4		
LICENSE NUMBER							
EXP	IRATIO	N DATE			-		
Г							

ARCHITECT UNDER THE LAWS

PROJECT INFORMATION

THRESHOLD TOWNHOUSE

400 EAST LAFAYETTE AVE BALTIMORE, MD 21202

> WARD 12 SECTION 11 **BLOCK 1096** LOTS 19/20 THRU 11

PROJECT NO THR-2020-09

SHEET TITLE


BUILDING **ELEVATIONS** & NOTES

DRAWING NUMBER **A-7**


SHEET NUMBER 7 of 8

EXTERIOR FINISH NOTES

DOOR AND WINDOW DETAILS

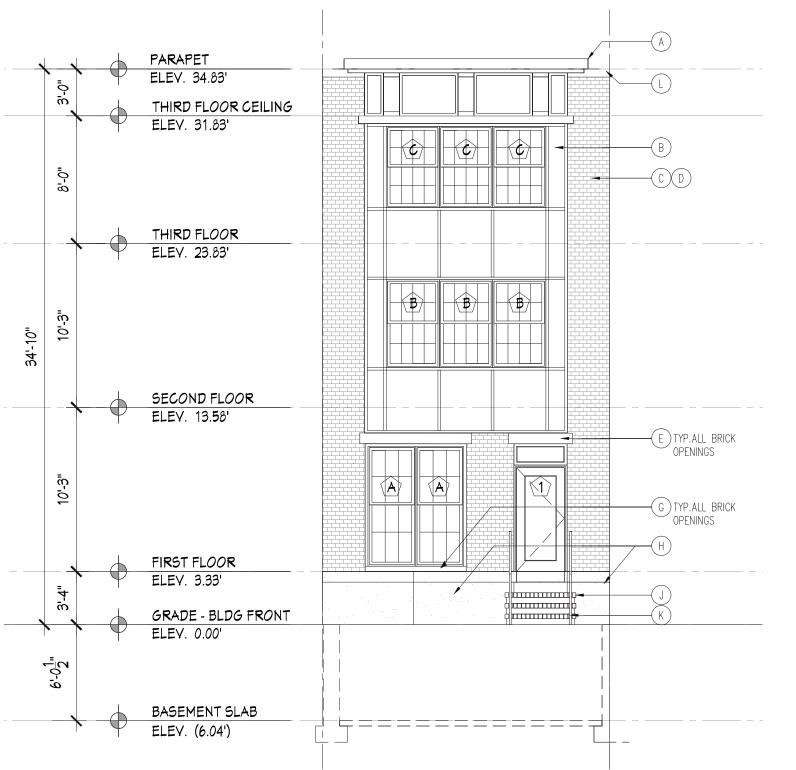


FRONT ELEVATION - LOT 19/20 - UNIT A

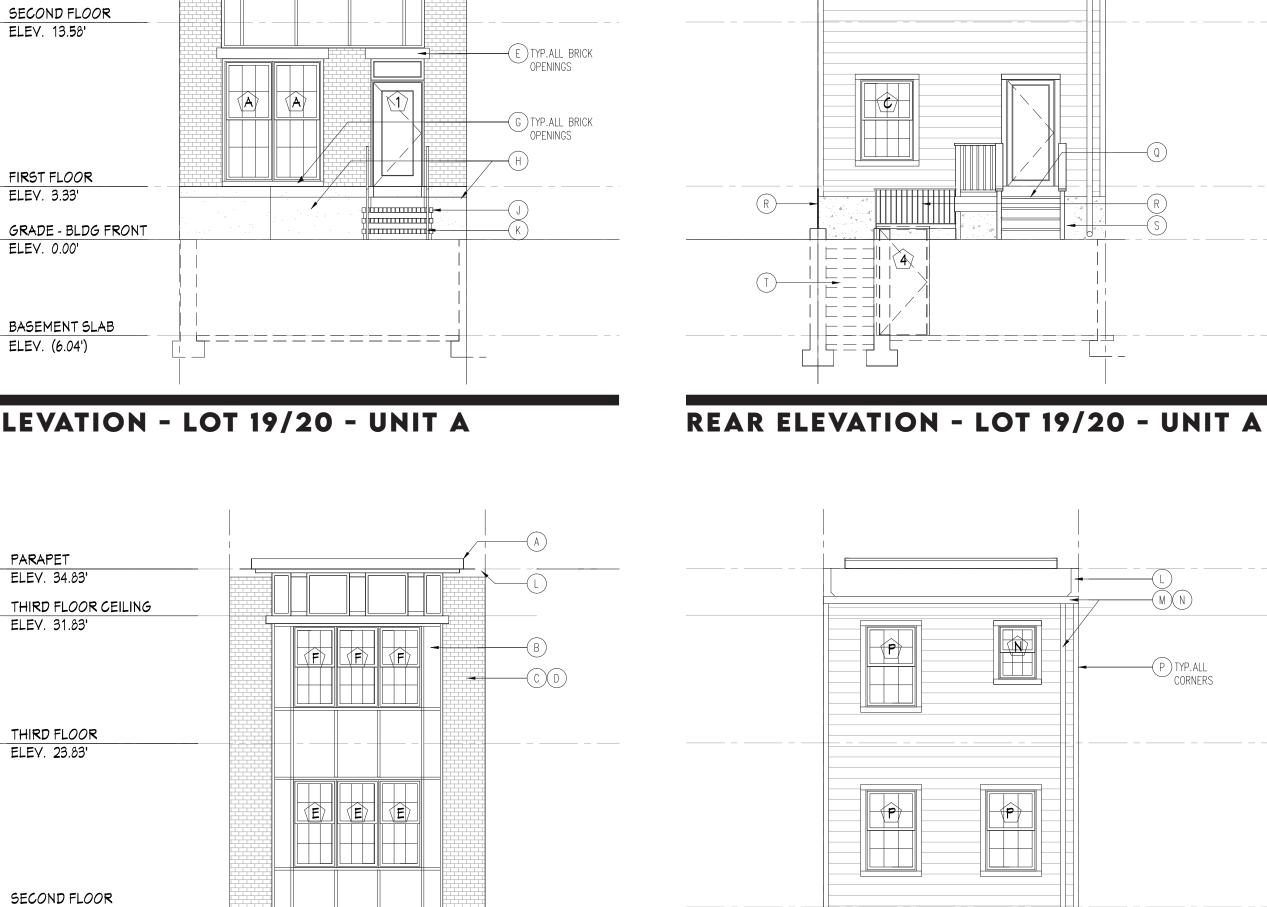


—(E)TYP.ALL BRICK OPENINGS

─(G)TYP.ALL BRICK OPENINGS

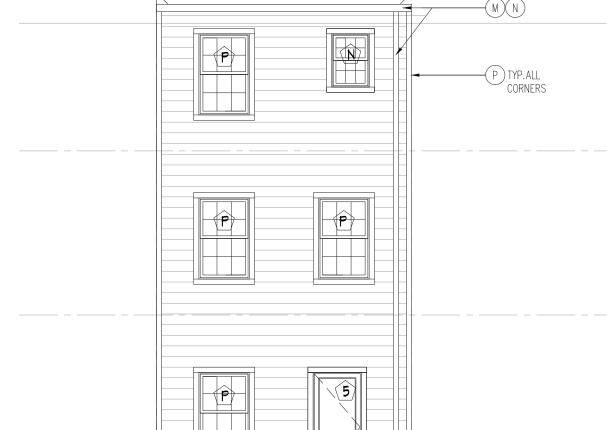

 \overline{M}

P TYP.ALL CORNERS

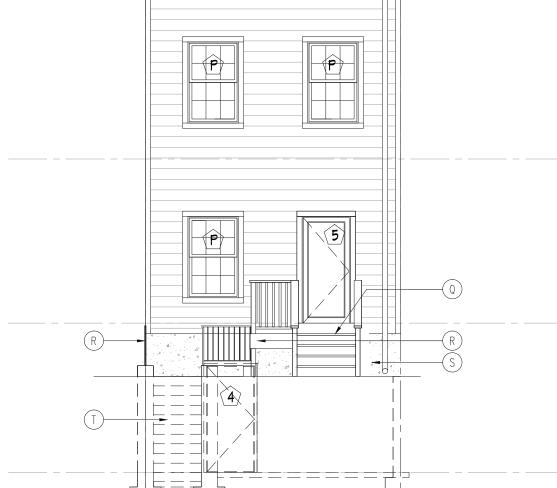

REAR ELEVATION - LOTS 11-18A - UNIT B/C

FIXED LEAF, 15 LITE

PARAPET ELEV. 34.83' THIRD FLOOR CEILING ELEV. 31.83' P TYP.ALL CORNERS THIRD FLOOR ELEV. 23.83' SECOND FLOOR ELEV. 13.58' \bigcirc ELEV. 3.33' GRADE - BLDG FRONT ELEY. 0.00' BASEMENT SLAB ELEV. (6.04')

E TYP.ALL BRICK OPENINGS

G TYP.ALL BRICK OPENINGS

(M)


SIDE ELEVATION - LOT 19/20 - BARCLAY STREET - UNIT A

SIDE ELEVATION - LOT 11 - BRENTWOOD ALLEY - UNIT C

EXTERIOR PRE-HUNG

Q _____

FRONT ELEVATION - LOTS 11-18A - UNIT B/C

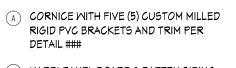

GRADE - BLDG FRONT

BASEMENT SLAB

ELEV. (6.04')

- HARDI-PANEL BOARD & BATTEN SIDING; FINISH: SMOOTH COLOR: TBD FROM "THE STATEMENT COLLECTION"
- BRICK VENEER DESIGN SPEC MANUF: BELDEN STYLE: SIMULATED BELCREST 530 SIZE: STANDARD MODULAR 3 ½" × 2 ½" × 7 ½"
- BRICK VENEER DESIGN SPEC (ALTERNATE) MANUF: BELDEN STYLE: GRAY; 691-693 SMOOTH SIZE: STANDARD MODULAR 3 ½" × 2 ½" × 7 ½"
- (E) δ" PRECAST CONCRETE LINTEL AT BRICK FACADES ONLY; EXTEND 4" BOTH SIDES OF OPENING.
- F NOT USED

- 4" PRECAST CONCRETE SILL AT BRICK FACADES ONLY; MATCH WINDOW WIDTH INCLUDING BRICK MOLDING
- 4" THICK LIMESTONE WAINSCOT PANELS; FRONT FACADE ONLY
- BRICK STEPS; MATCH VENEER
- $\stackrel{\frown}{\mathsf{K}}$ 1-1/2" WROUGHT IRON HANDRAILS WITH $^1\!\!/_2$ ". PICKETS AT 4" O.C.; HANDRAIL HEIGHT 38" ABOVE STAIR TREADS; TYPICAL BOTH
- 2" BRONZE ALUMINUM WALL CAP WITH DRIP EDGE OVER PRESSURE TREATED (P.T.) 2" WOOD PLATE ; TYPICAL ON BRICK VENEER WALLS AND DEMISING WALLS
- M 6" HARDI-BOARD TRIM
- (N) 6" K-STYLE ALUMINUM GUTTER WITH 4" DIA. DOWNSPOUT; TYPICAL ONE SIDE

PICKETS PER DETAIL X-XX; APPLY TWO (2) COATS CLEAR MATTE WATERSEAL.

(P) 4" HARDI-BOARD TRIM DOOR AND WINDOW SURROUNDS P.T. WOOD DECK INCLUDING RAILING AND


- RAILING TO TOP OF CONCRETE FOUNDATION WALL. PROVIDE SINGLE LINE RAILING FOR BASEMENT STEPS. PROVIDE
 - BRACKET TO ALLOW INSTALLATION ON CONCRETE WALL; TYPICAL ONE SIDE BRICK STAMP CONCRETE FOUNDATION MALL; NOT PAINTED
 - CONCRETE STEPS TO GRADE FROM MALKOUT BASEMENT

DOOR SCHEDULE

COMBINATION FULL LITE

DOORS 1 THRU 3 BASED

ON ANDERSEN 200

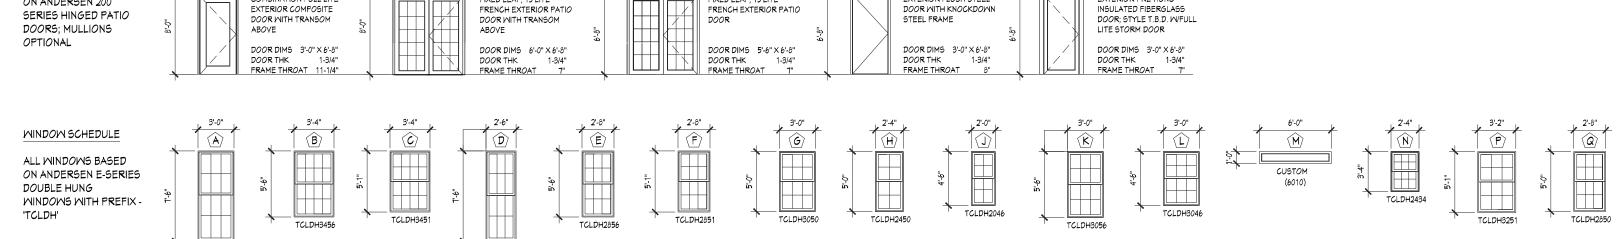

FIXED LEAF, 15 LITE

EXTERIOR FLUSH STEEL

EXTERIOR FINISH NOTES DOOR AND WINDOW DETAILS



PARAPET ELEV. 34.83'

THIRD FLOOR

SECOND FLOOR

ELEV. 13.58'

FIRST FLOOR

BASEMENT SLAB

ELEV. (6.04')

ELEV. 3.33'

ELEV. 23.83'

VISION DDB LLC

ED NOTTINGHAM, JR EDNOTTY@VISIONDDB.COM 443.677.0985

APPLICANT JOHN COLLICK 711 MATTHEWS AVENUE BALTIMORE, MD 21225

> OWNER JOHN & ERIN COLLICK 711 MATTHEWS AVENUE

BALTIMORE, MD 21225

CONTRACTOR JOHN COLLICK

711 MATTHEWS AVENUE

BALTIMORE, MD 21225

SUBMISSION DATE NOVEMBER 11, 2021

	NO.	REVISION	ву	DAT
	1			
	2			
	3			
	4			
	5			
	6			
	7			
1		l		

A DULY LICENSED PROFESSIONAL ARCHITECT UNDER THE LAWS OF THE STATE OF MARYLAND.

EXPIRATION DATE _

PROJECT INFORMATION

THRESHOLD TOWNHOUSES

400 EAST LAFAYETTE AVE BALTIMORE, MD 21202

WARD 12 SECTION 11 **BLOCK 1096** LOTS 19/20 THRU 11

PROJECT NO THR-2020-09

SHEET TITLE

ELEVATIONS NOTES

> **DRAWING NUMBER A-8**

SHEET NUMBER 8 OF 8